

TABLE OF DIMENSIONAL REQUIREMENTS RESIDENCE B DISTRICT (ZONE RB)

			LOT 1	LOT 2
	REQUIRED	EXISTING	PROP	OSED
MIN LOT AREA (SF)	10,000	21,443.20	10,037.26	11,102.57
MIN. LOT FRONTAGE (FEET)	50	174.20	76.10	98.10
FRONT YARD TO LOT LINE (FEET)	33.5	46.05	33.50	33.50
FRONT YARD TO SIDEWALK EDGE(FEET)	40	-	40.00	40.00
SIDE YARD (FEET)	15	49.38	15.00	15.00
TOTAL SIDE YARDS (FEET)	30	106.64	30.00	30.10
REAR YARD (FEET)	40	49.00	40.00	40.00
MAX. BUILDING COVERAGE (%)	50	15.58%	28.67%	25.40%
MAX. HEIGHT (STORIES)	2.5	-	TBD	TBD

**TOTAL NUMBER PARKING SPACES:** 

2 PARKING SPACES PER DWELLING UNIT

TOTAL UNITS = 4

8 PARKING SPACES REQUIRED


8 PARKING SPACES PROPOSED


TOTAL PARKING PROVIDED: 8 PARKING SPACES

# SHEET INDEX:


- SITE PLAN
- 2. DEMOLITION PLAN
- GRADING PLAN
- 4. DRAINAGE PLAN
- UTILITY PLAN
- 6. SOIL EROSION & SEDIMENT CONTROL PLAN
- 7. DETAILS SHEET

HEREBY CONSENT TO THE FILING OF THIS SITE PLAN INCLUDING ALL DESIGN CONCEPTS, NOTES, STIPULATIONS AND OTHER INFORMATION INDICATED THEREON.

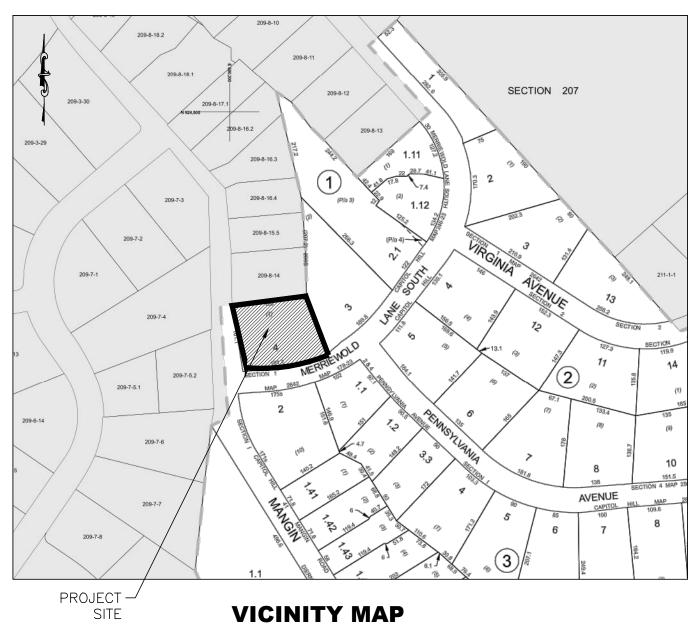

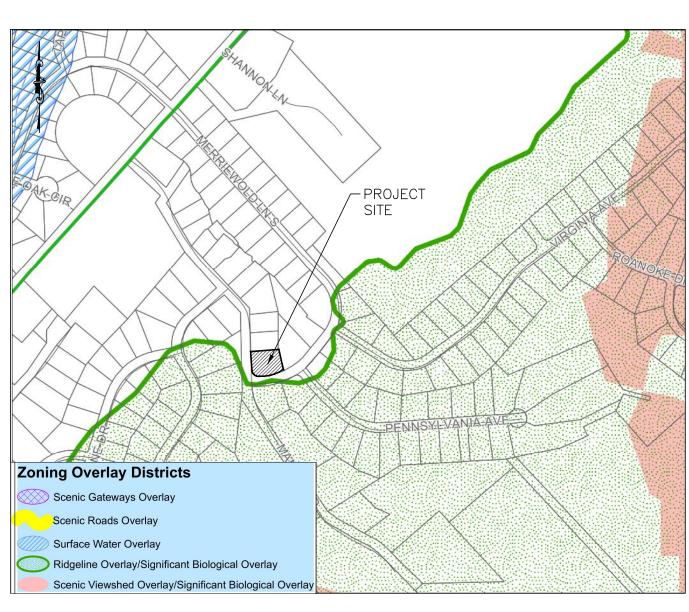

**OVERLAY DISTRICT MAP** NTS

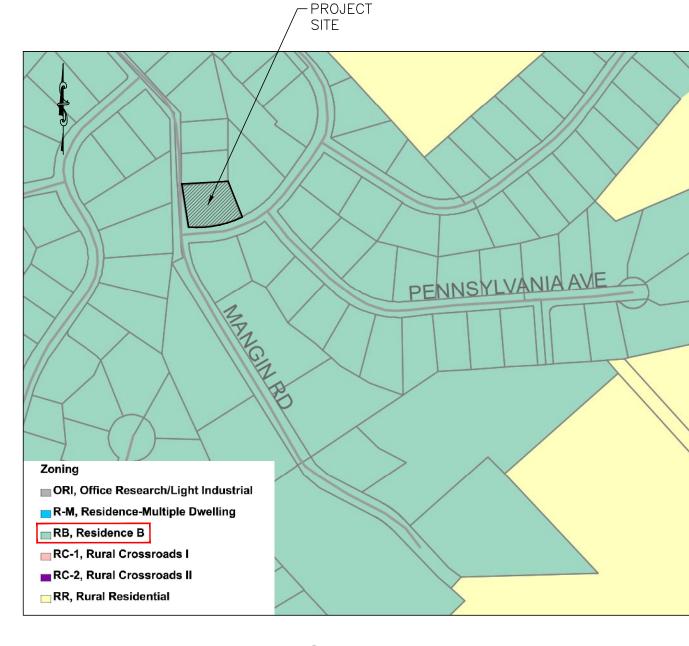

**ZONE MAP** NTS




(IN FEET) 1 inch = 20 ft.

**TERRANOVA** ENGINEERING CONSULTANTS TERRANOVA ENGINEERING CONSULTANTS DPC NEW YORK LICENSE No. 0022576

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SITE LAYOUT DATE DR/CK NO. REVISION

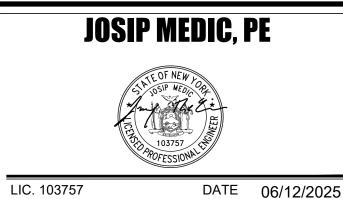


# **SITE PLAN** DRAWN BY: CHECKED BY:

EB


DESIGN BY:

40 MERRIEWOLD LN S 40 MERRIEWOLD LANE S, VILLAGE OF SOUTH BLOOMING GROVE, TOWN OF BLOOMING GROVE, ORANGE COUNTY, NY 10950 SBL 210-1-4

DRAWING NUMBER:	SCALE:	FILE NO.:	DATE:
<b>01</b> of <b>07</b>	1": 20'	25130	05/13/2025

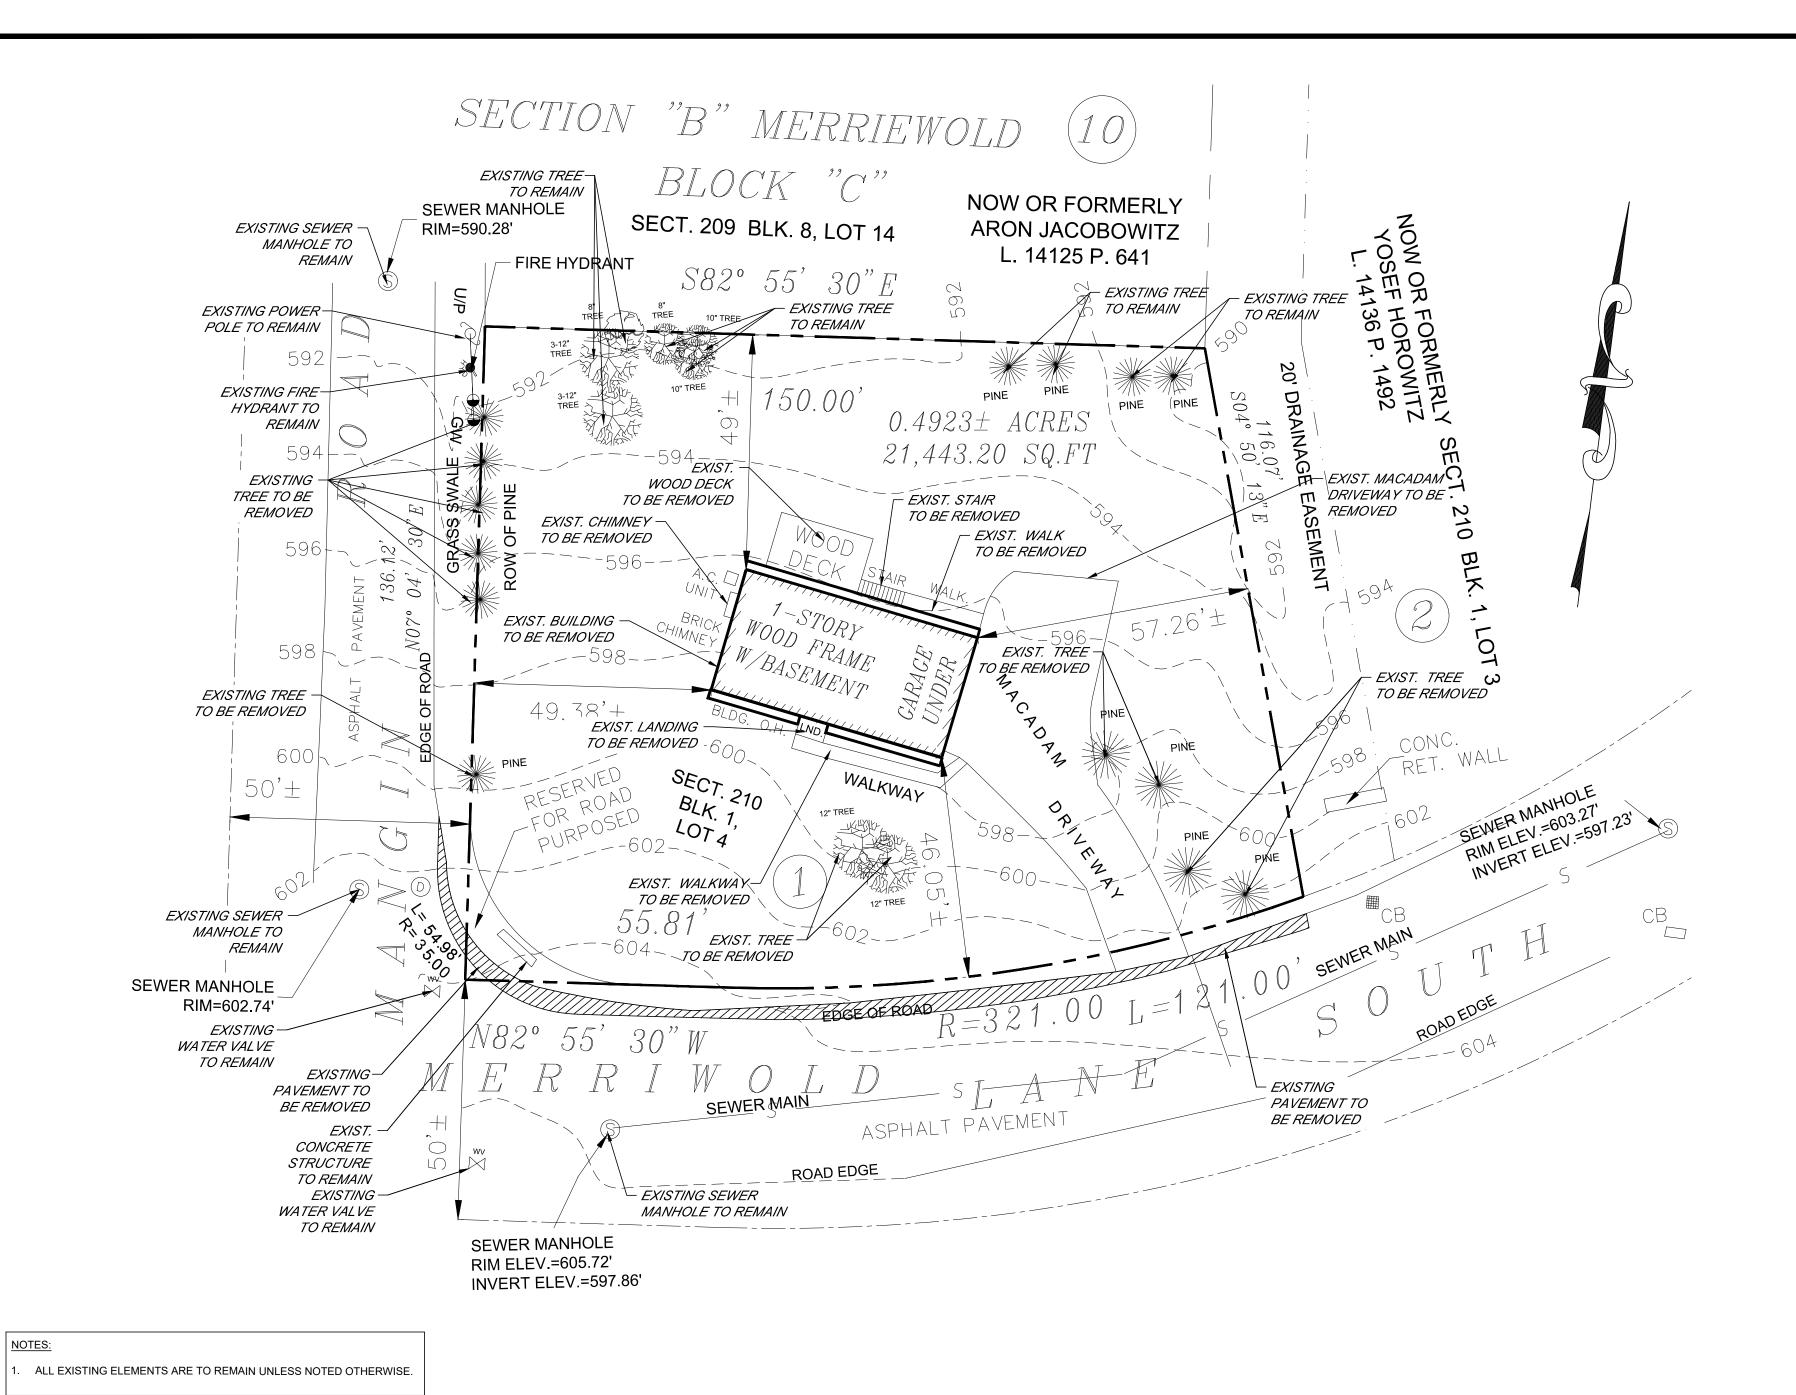


Call Safely. New York before you dig

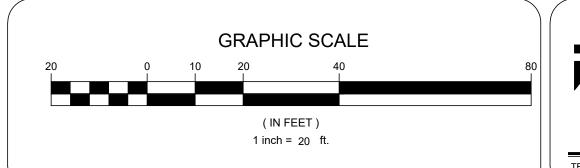

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1	SITE LAYOUT	06/12/2025	ER/YB	
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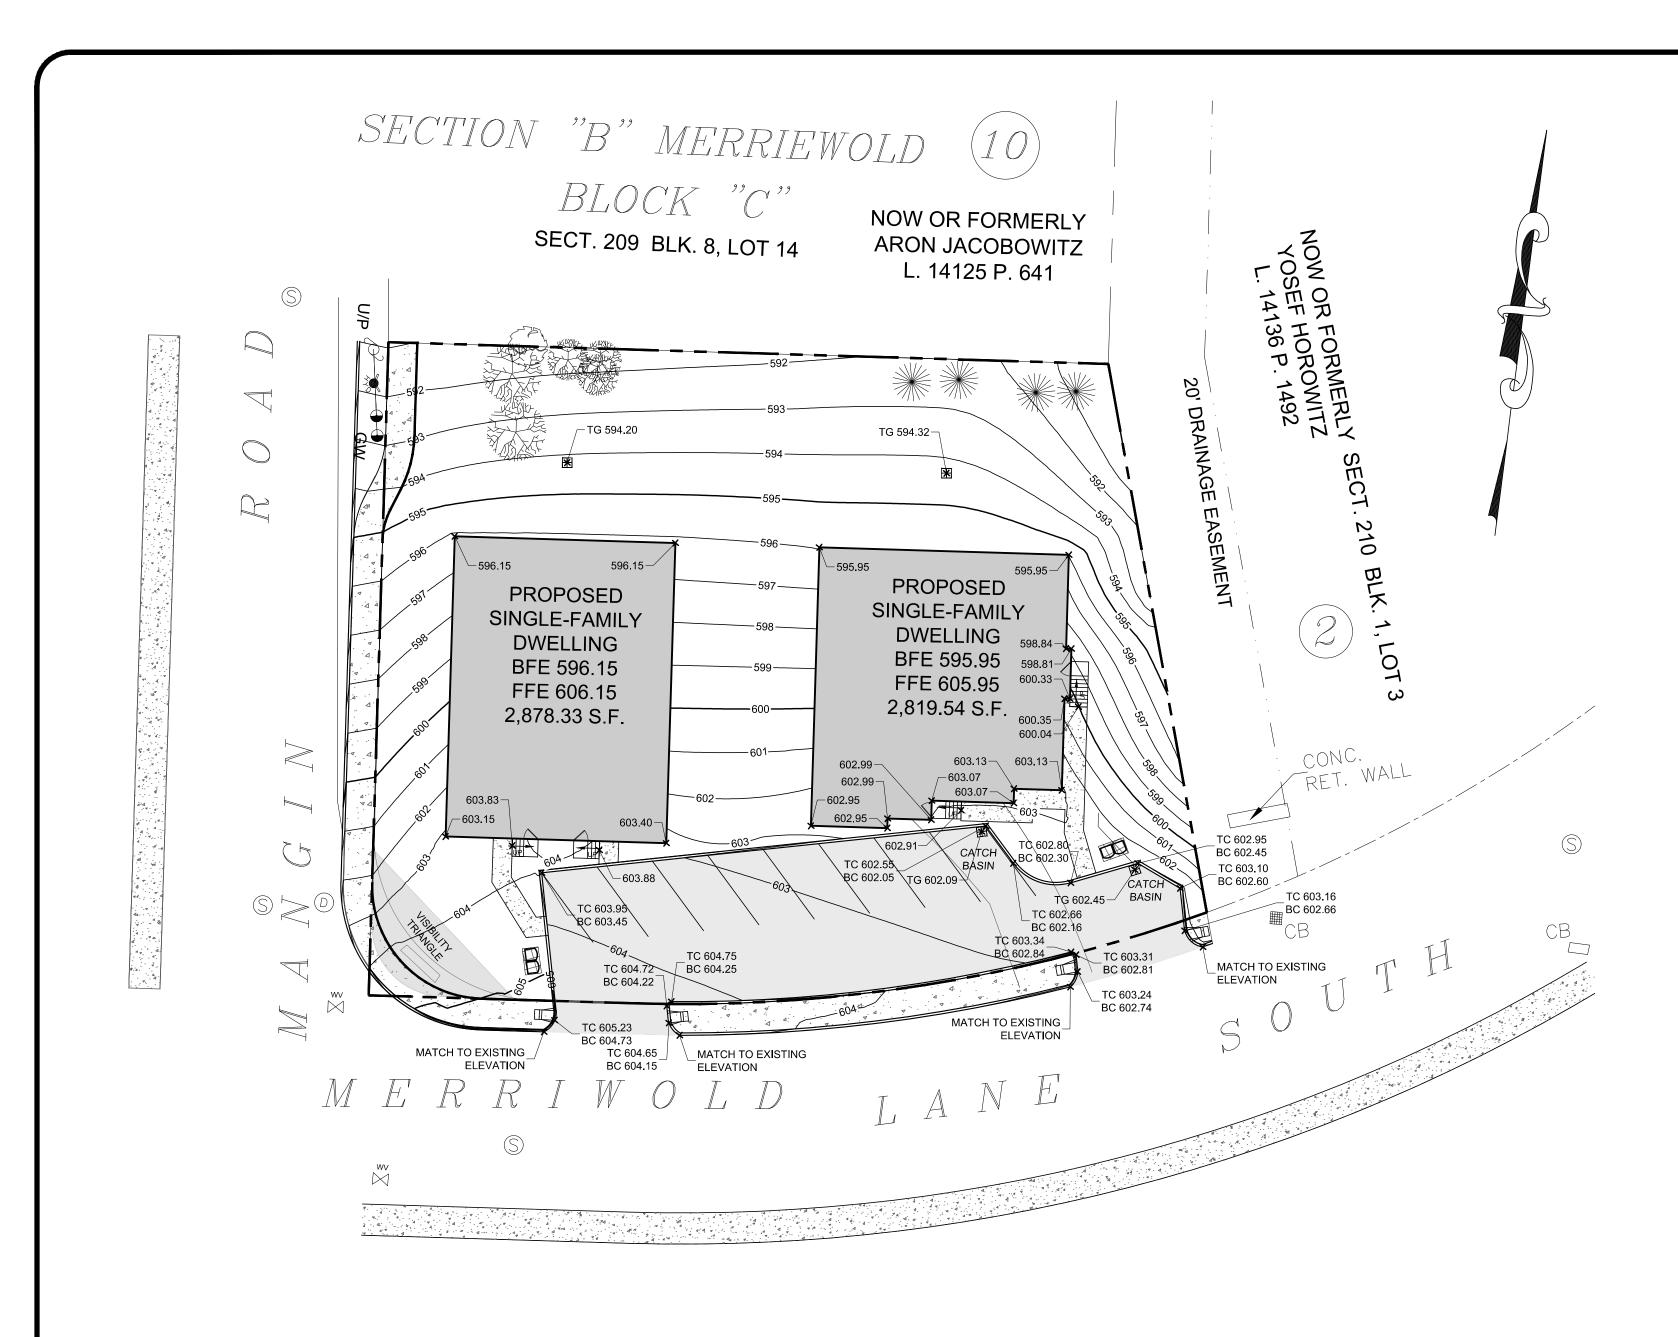
DEN	OLITION PLA	<b>N</b>
DESIGN BY:	DRAWN BY:	CHECKED BY:

JM

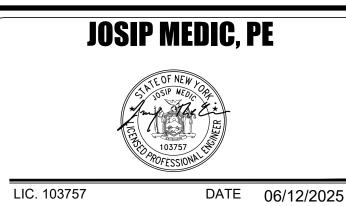EB

40 MERRIEWOLD LN S
40 MERRIEWOLD LANE S, VILLAGE OF SOUTH BLOOMING GROVE,
TOWN OF BLOOMING GROVE, ORANGE COUNTY, NY 10950
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<b>02</b> of <b>07</b>	1"=20'	25130	05/13/2025



LEGEND:

BFE BASEMENT FLOOR ELEVATION

FFE FIRST FLOOR ELEVATION

TG TOP OF GRATE

TC TOP OF CURB

BC BOTTOM OF CURB

(800) PROPOSE GRADE





J	OSIP MEDIC, I	PE
	SENTE OF NEW POOR SIP MEDIC OFF	
LIC. 103757	DATE	06/12/2025

GRADING PLAN	

CHECKED BY:

JM


DRAWN BY:

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40 MERRIEWOLD LANE S, VILLAGE OF SOUTH BLOOMING GROVE,
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SBL 210-1-4

DRAWING NUMBER:	SCALE:	FILE NO.:	DATE:
<b>03</b> of <b>07</b>	1"=20'	25130	05/13/2025



# LEGEND:

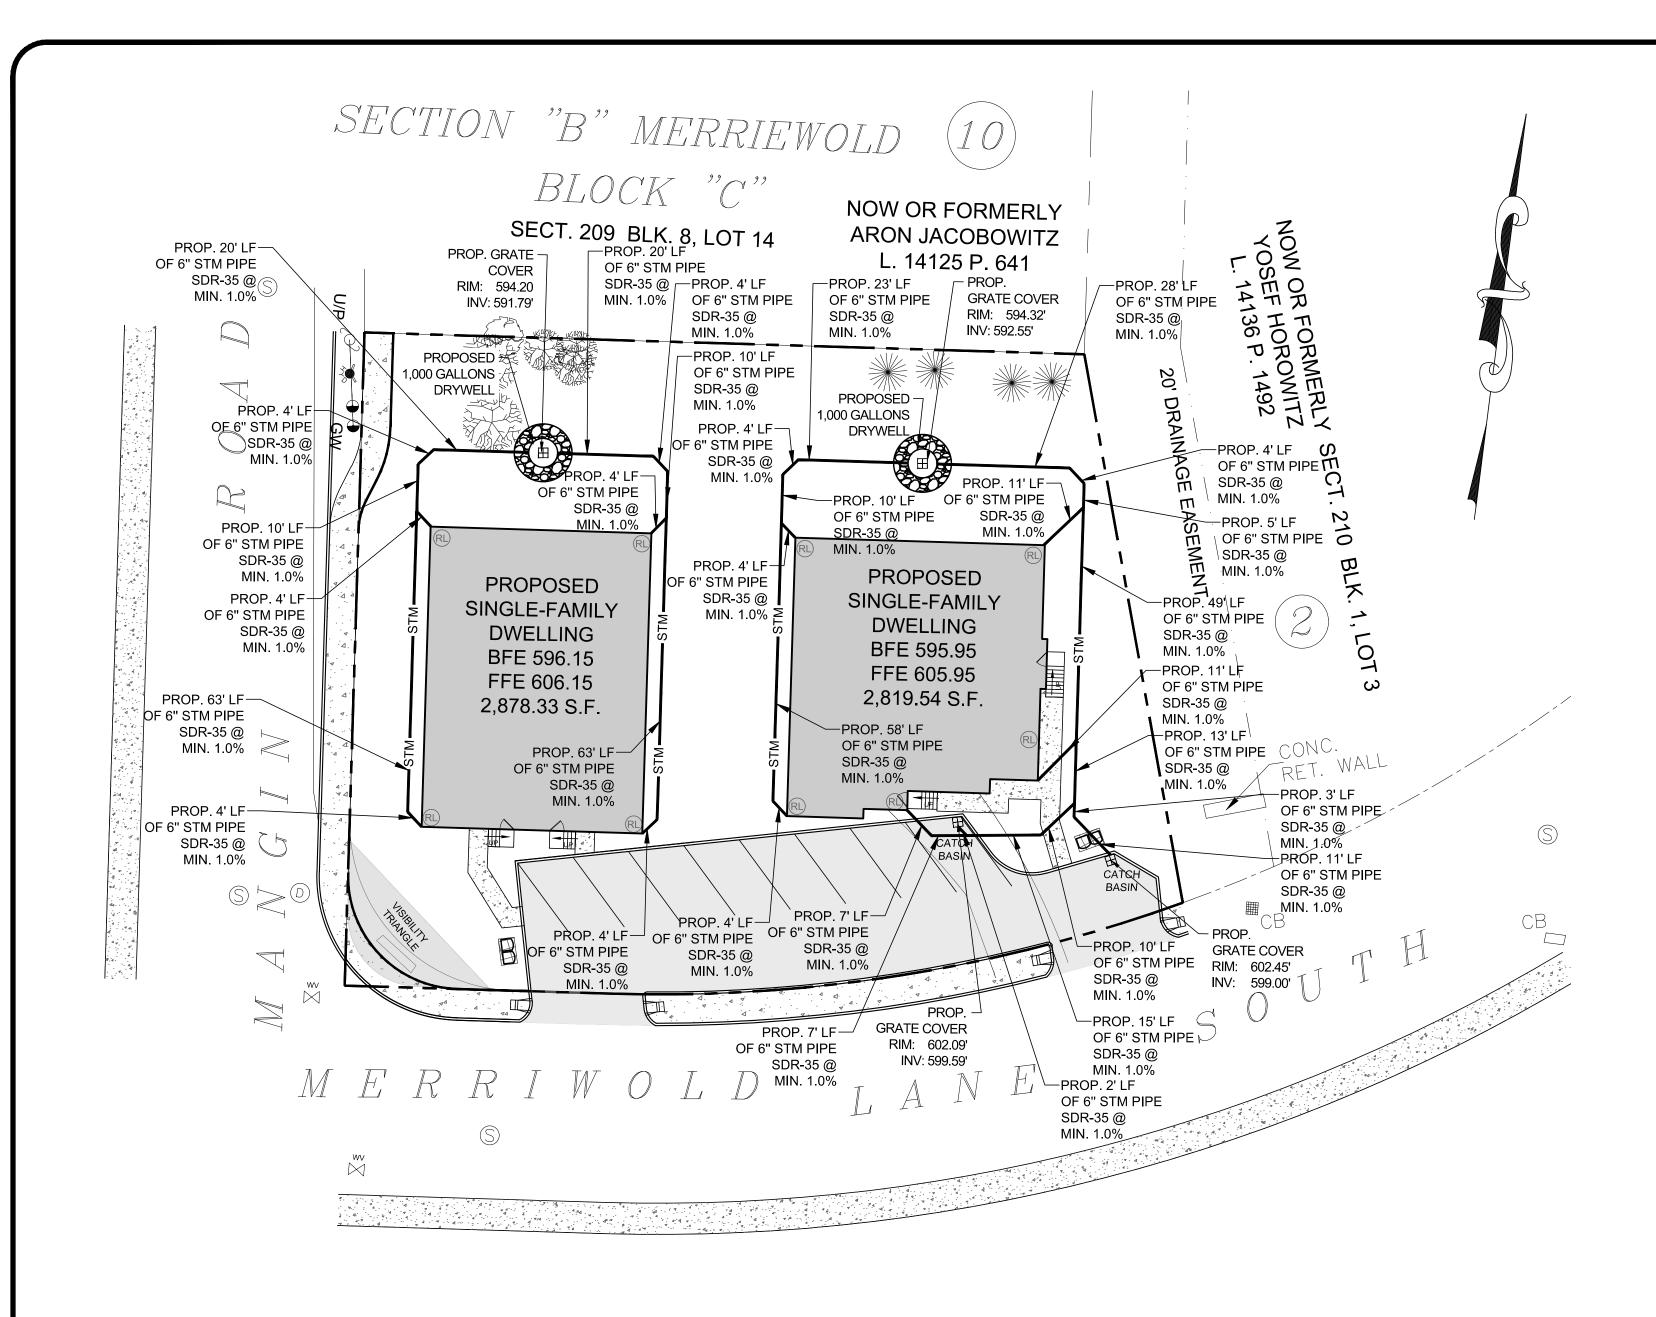PROPOSED 6" PVC ROOF LEADER PER STORM DRAIN DETAILS.

#### RECHARGE NOTES:

- RECHARGE DRYWELLS ARE TO BE LOCATED A MINIMUM OF 10-15 FEET FROM THE FOUNDATION WITH AN INVERT 1 FOOT LOWER THAN THE BASEMENT FLOOR
- 2. THE SYSTEM COLLECTS AND RECHARGES THE CLEAN RUNOFF FROM THE ROOF. IN THE EVENT THAT THE SYSTEM FAILS AND NO LONGER RECHARGES WATER, THE SYSTEM WILL OVERFLOW OUT OF GRADE COVER. RUNOFF WILL THEN FLOW ACROSS THE LAWN AREA WHICH IS STABILIZED WITH GRASS OR OTHER GROUND COVER. THERE SHOULD BE NO CATASTROPHIC FAILURE THAT WOULD CAUSE DAMAGING EROSION DURING NORMAL STORM EVENTS.

#### RUNOFF CALCULATIONS FOR EACH LOT:

5,430.27 SF (PROPOSED COVERAGE)

0.50 INCH/ 2 HOUR STORM

5,430.27 SF X 0.50 IN X 1 FT/12 INCHES

= 226.26 CF REQUIRED

1 DRYWELL = 500 GAL = 66.84 CF

PROPOSED STONE RING & BASE STONE ANNULAR RING VOLUME (3 FT) =  $\pi$  x (6 FEET^2 - 3 FEET^2) x 6 FEET

STONE ANNULAR RING VOLUME = 508.94 CF

STONE BASE AREA (1 FT) =  $\pi$  x 6 FEET^2 = 113.09 SQF STONE BASE VOLUME = 113.09 SQF X 1 FT =113.09 CF

TOTAL STONE = 622.03 CF STONE VOID = 40%

TOTAL DETENTION VOLUME PER DRYWELL= DRYWELLS + STONE VOID


TOTAL DETENTION VOLUME FER DRYWELL - DRYWELLS + STONE VOID TOTAL DETENTION VOLUME = 66.84 CF + (622.03 CF x 0.40)


TOTAL DETENTION VOLUME = 315.65 CF


TOTAL DRYWELL PROVIDED=1

TOTAL DETENTION VOLUME PROVIDE= 315.65 CF > 236.00 CF

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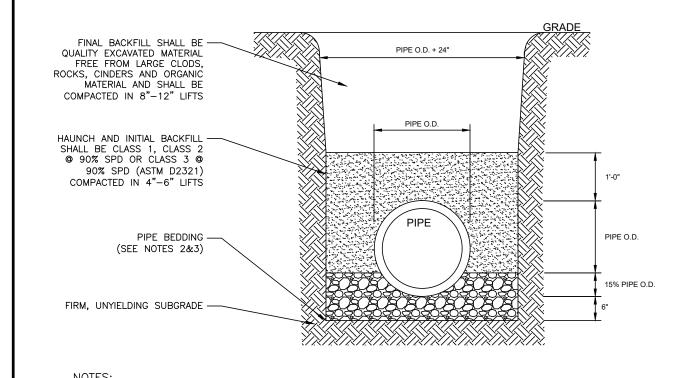


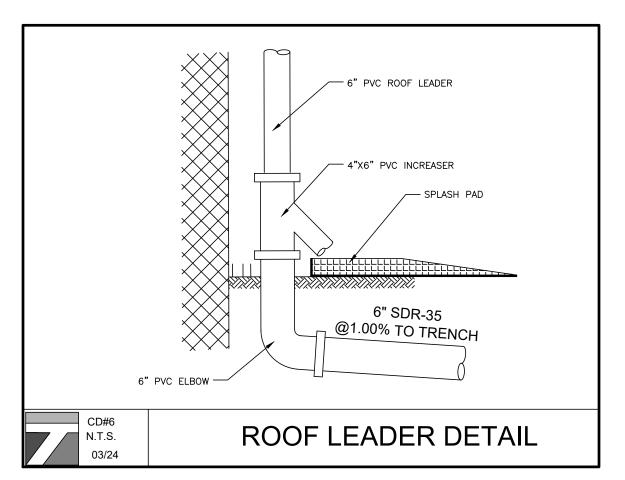

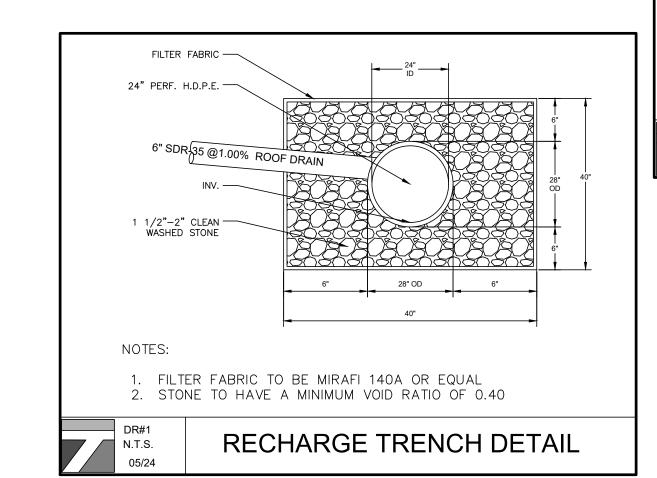

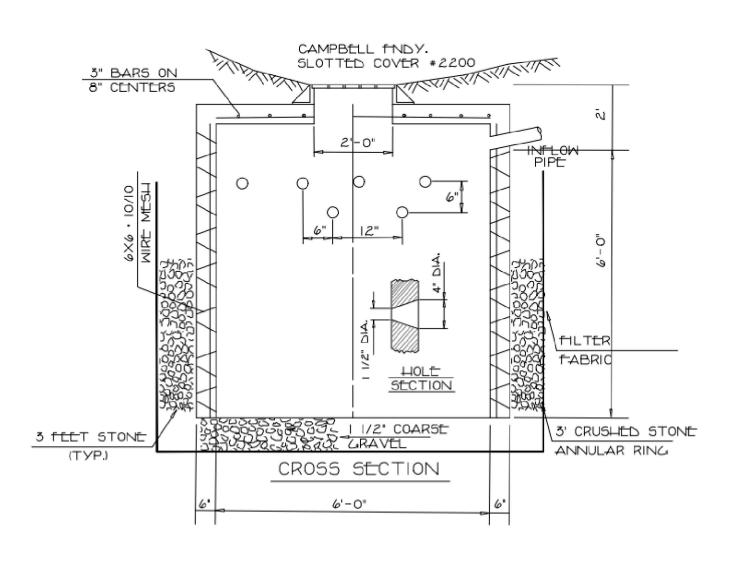DETENTION BASIN DRYWELL

DESIGN BY:



 SOIL CLASSES AS DEFINED IN ASTM D 2487 AND D 2321.
 PIPE BEDDING FOR STORM SEWERS SHALL BE CLASS 1 EMBEDMENT MATERIAL OR CLASS 2 OR 3 EMBEDMENT MATERIAL COMPACTED TO 90% STANDARD PROCTOR

MANUFACTURER'S INSTALLATION GUIDES AND REQUIREMENTS.


DENSITY.
3. PIPE BEDDING FOR WATERMAIN SHALL BE CLASS 1 EMBEDMENT MATERIAL OR

4. PARTICLE SIZE IN THE EMBEDMENT ZONE SHALL NOT EXCEED 2"
5. WHERE UNSUITABLE MATERIAL IS ENCOUNTERED IN TRENCH BOTTOM, UNDERCUT TO


SUITABLE MATERIAL.

6. PIPE BEDDING AND BACKFILL IS TO BE IN ACCORDANCE WITH PIPE


PIPE BEDDING & BACKFILL DETAIL

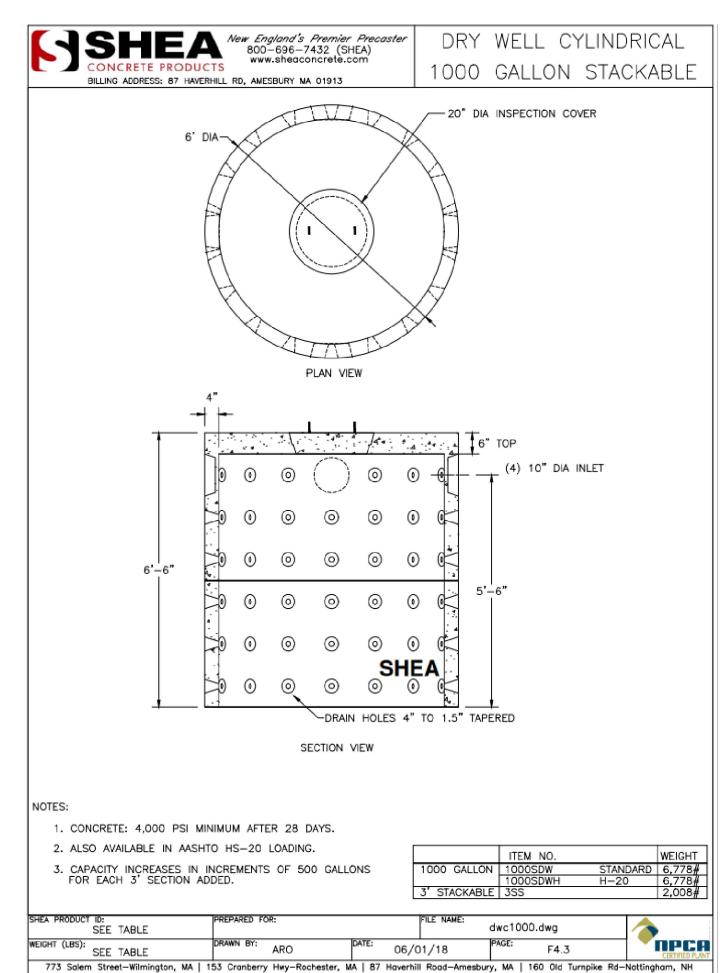




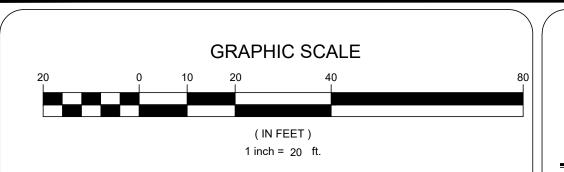



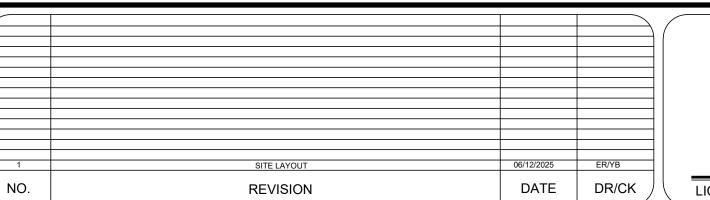


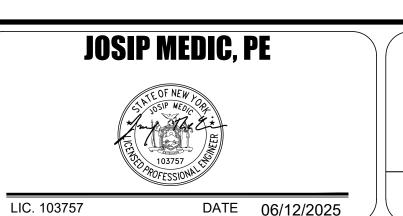



DR	RAINAGE PLAN	J
	DRAWN BY:	CHECKED BY:


40 MERRIEWOLD LN S
40 MERRIEWOLD LANE S, VILLAGE OF SOUTH BLOOMING GROVE,
TOWN OF BLOOMING GROVE, ORANGE COUNTY, NY 10950
SBL 210-1-4

DRAWING NUMBER: SCALE: FILE NO.: DATE: 04 OF 07 25130 05/13/2025

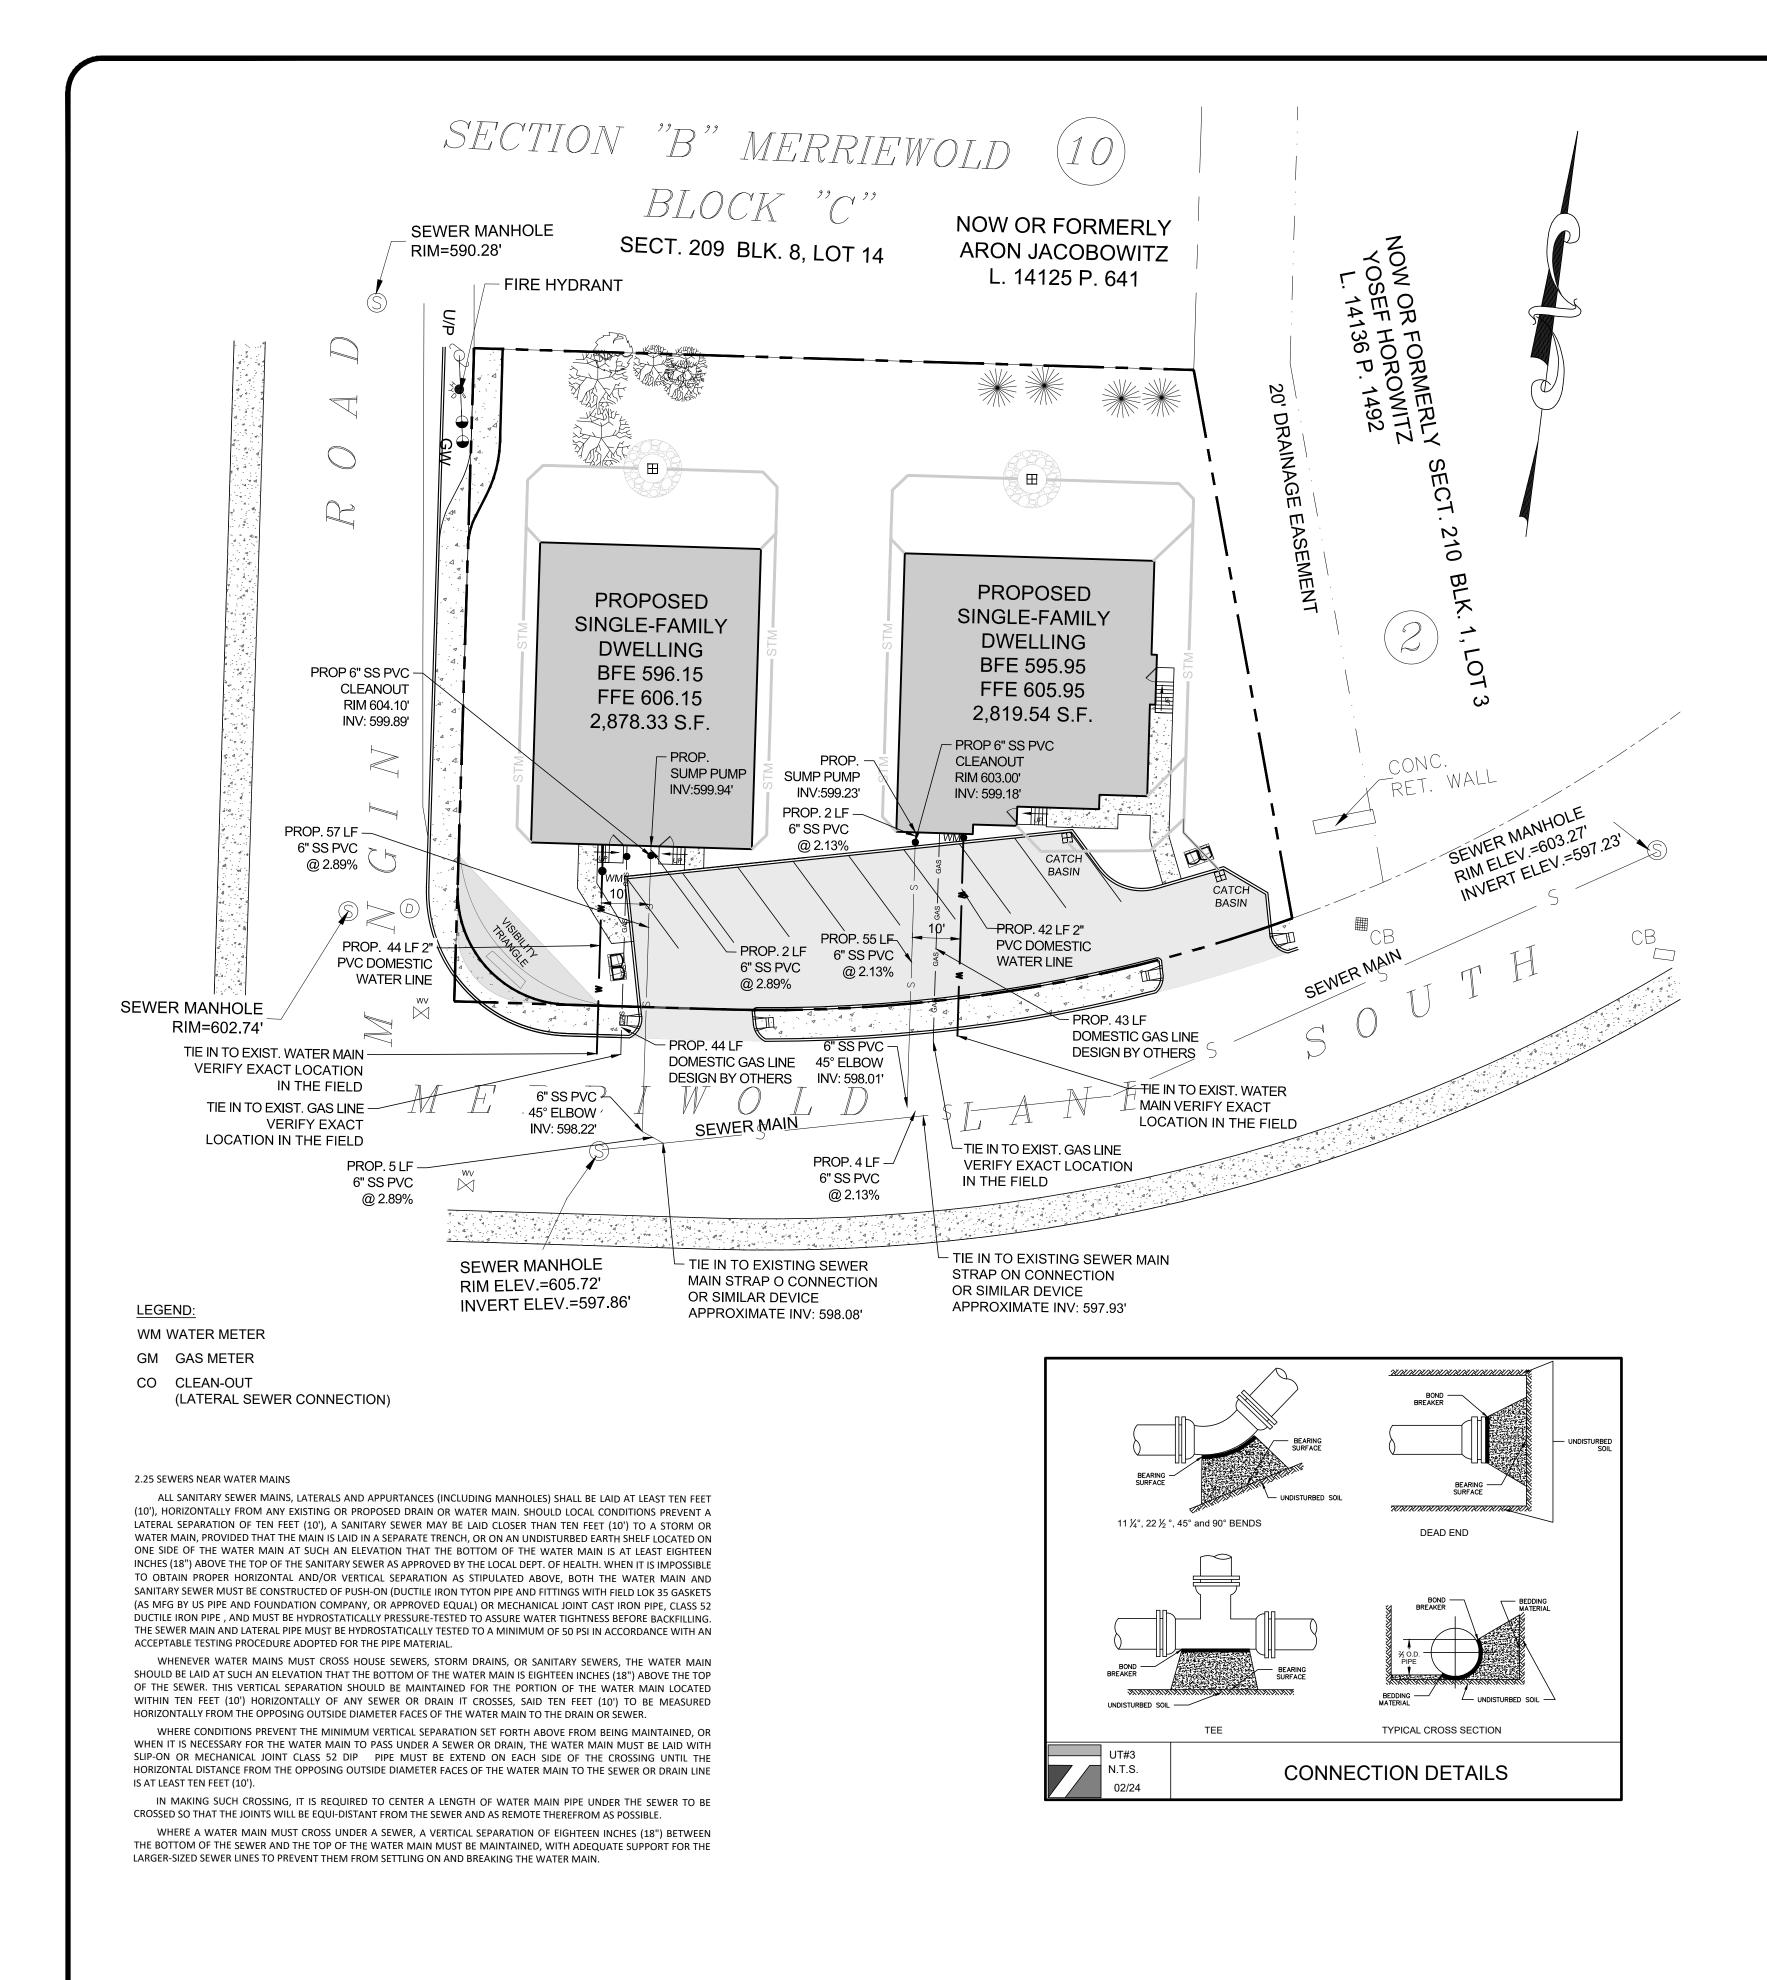

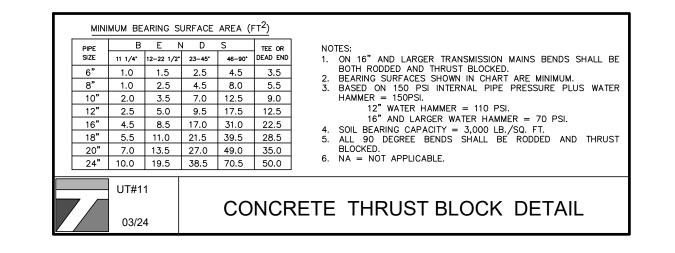


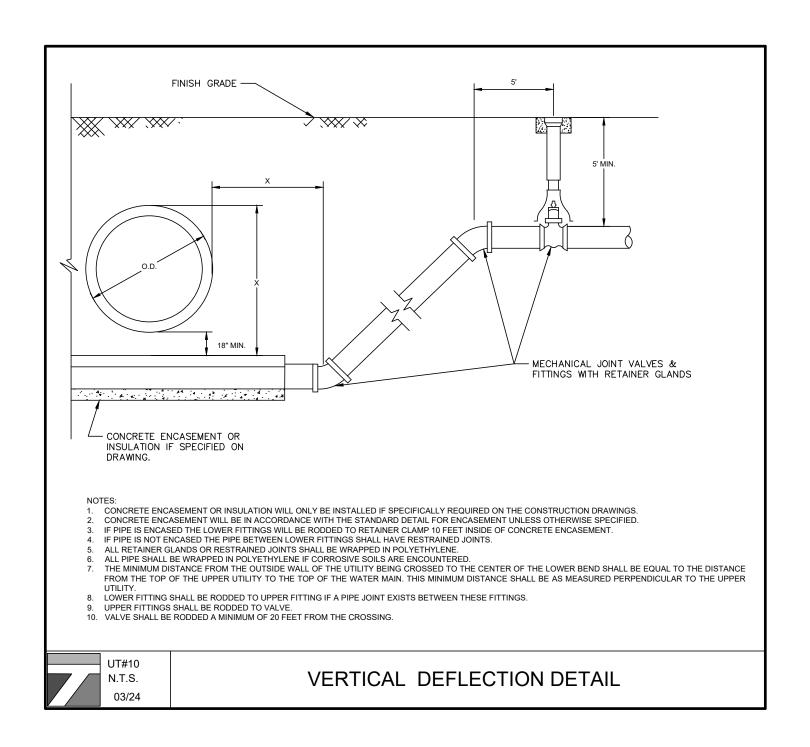

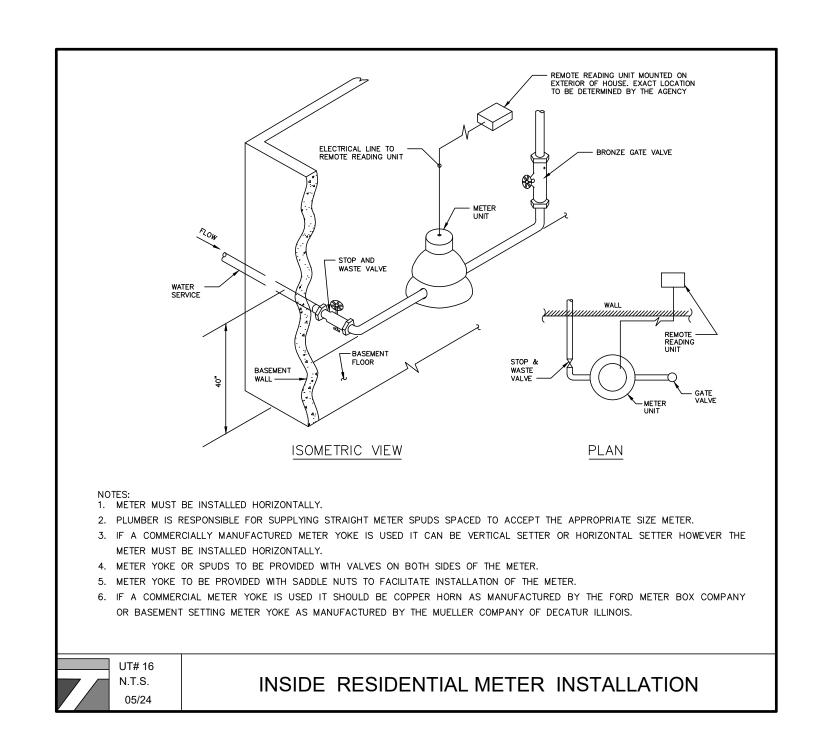

**DESIGN BY** 




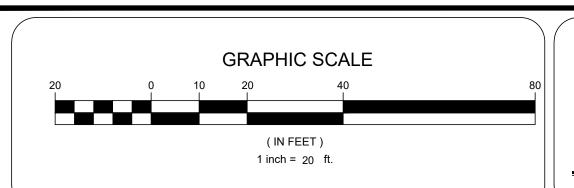



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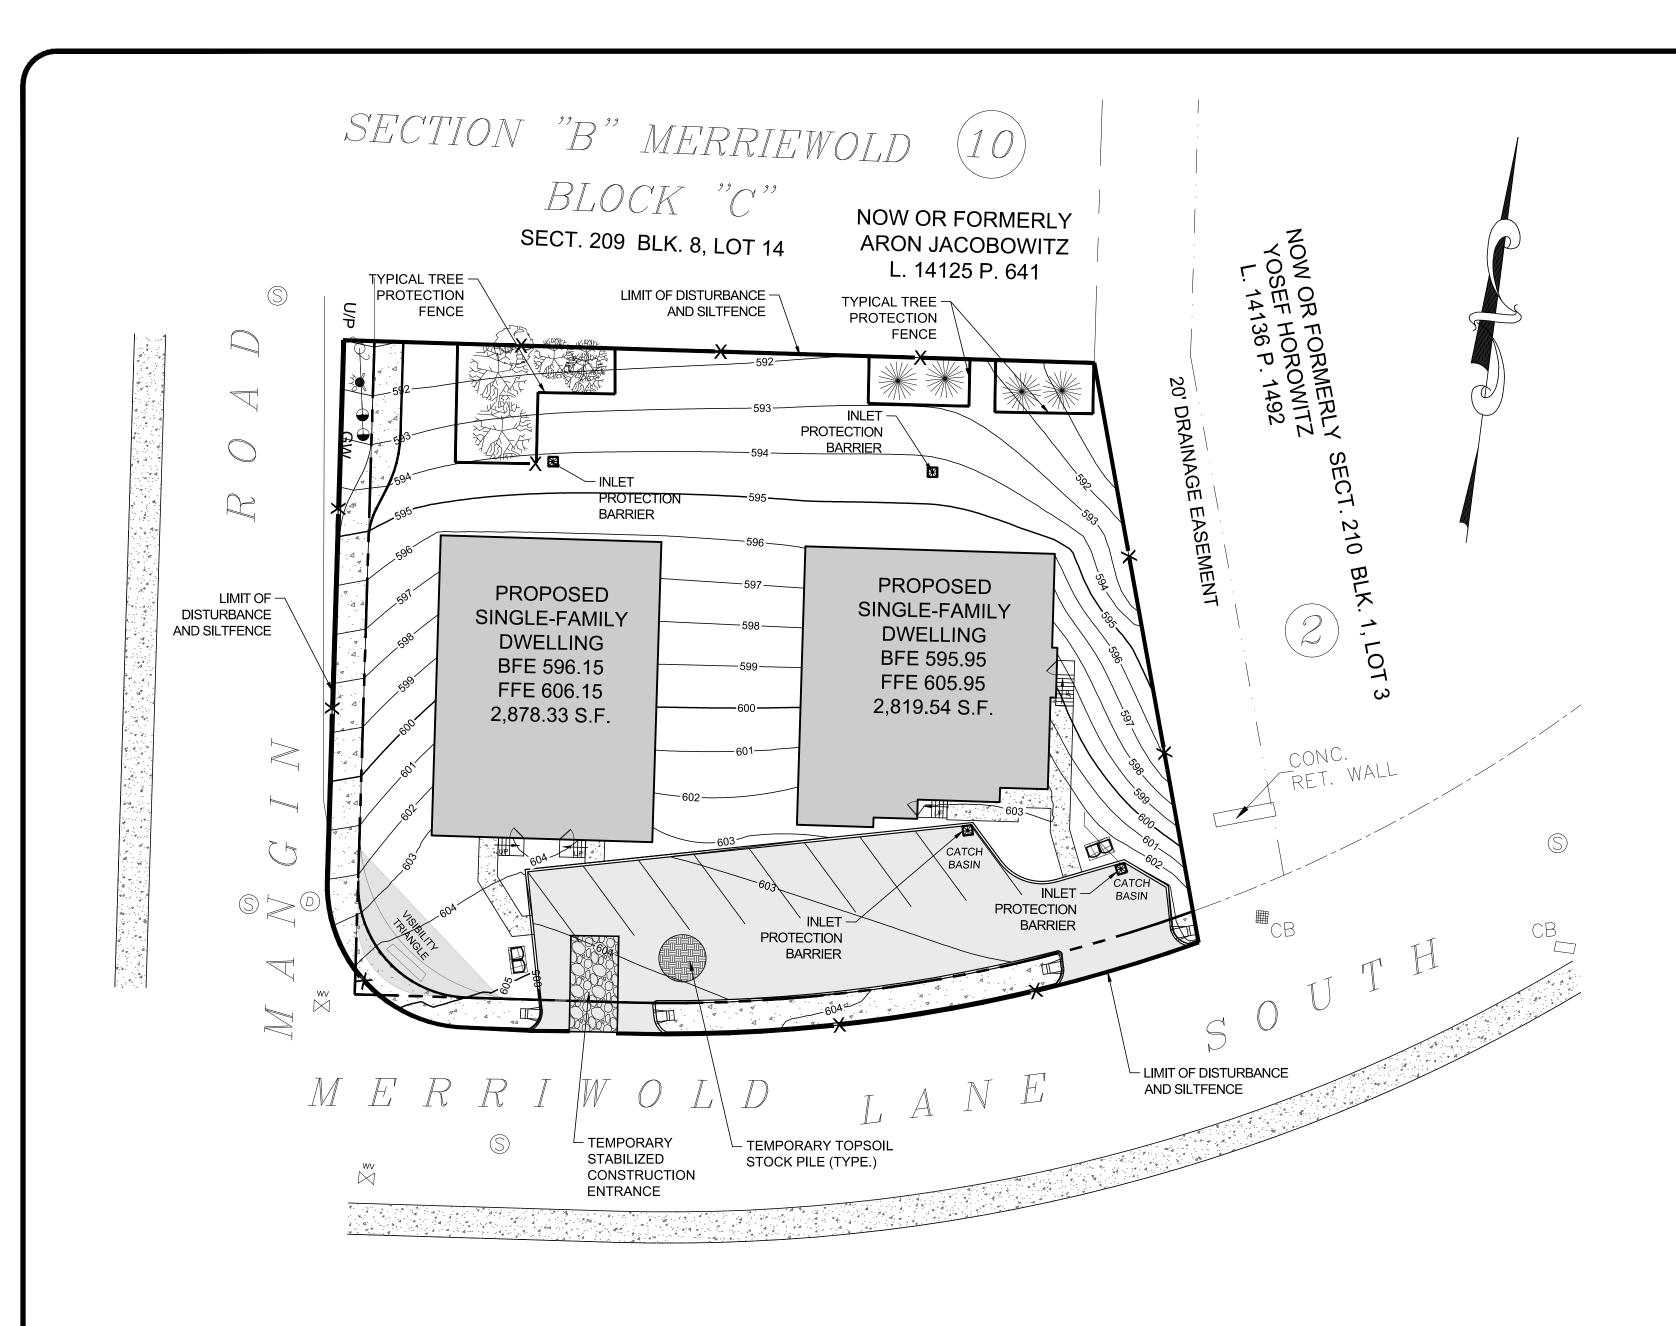



U	TILITY PLAN		
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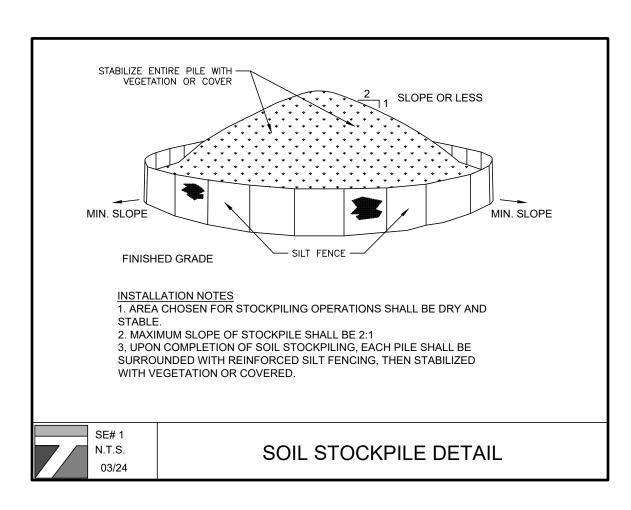
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5 of <b>07</b>	1"=20'	25130	05/13/2025

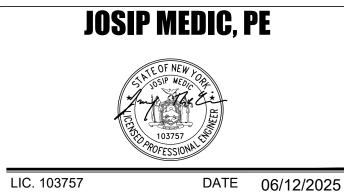





### **LEGEND:**

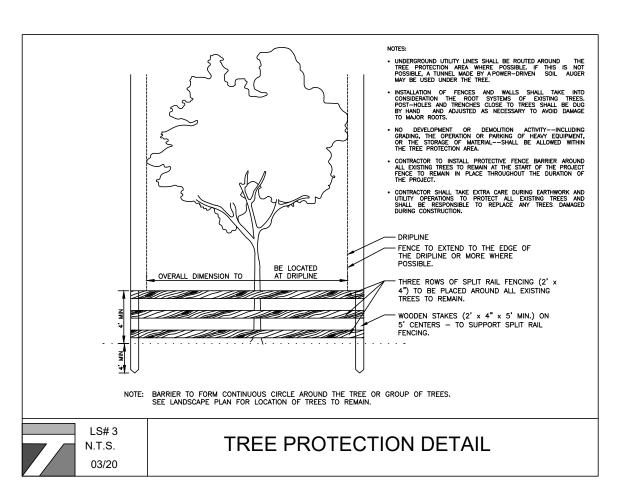REINFORCED FILTER FABRIC BARRIER



STABILIZED CONSTRUCTION EXIT



INLET PROTECTION BARRIER

NOTES:

1. AREA OF DISTURBANCE: 23,326.91 SF.

#### SEQUENCE OF CONSTRUCTION NOTES

1. CONTRACTOR SHALL IMPLEMENT INLET PROTECTION DEVICES AND REINFORCED FILTER FABRIC BARRIER ALONG ROAD AND SIDE DITCHES AT LOCATION SHOWN ON THE TYPICAL STORM WATER POLLUTION PREVENTION (SWPPP) PLANS TO KEEP SILT AND /OR EXCAVATED MATERIALS FROM ENTERING INTO THE STORM WATER INLETS AND DITCHES EVENTUALLY POLLUTING THE RECEIVING STORM.

2. DURING THE EXCAVATION PHASE OF THE PROJECT, CONTRACTOR SHALL SCHEDULE THE WORK IN SHORT SEGMENTS SO THAT EXCAVATED MATERIAL CAN BE QUICKLY HAULED AWAY FROM THE SITE AND TO PREVENT IT FROM STAYING UNCOLLECTED ON THE EXISTING PAVEMENT. ANY LOOSE EXCAVATED MATERIAL WHICH FALLS ON PAVEMENTS OR DRIVEWAYS SHALL BE SWEPT BACK INTO THE EXCAVATED AREA.

3. CONTRACTOR SHALL CLEAN UP THE EXISTING STREET INTERSECTIONS AND DRIVEWAYS DAILY, AS NECESSARY, TO REMOVE ANY EXCESS MUD, SILT OR ROCK TRACKED FROM THE EXCAVATED AREA.


4. CONTRACTOR SHALL FOLLOW GOOD HOUSEKEEPING PRACTICES DURING THE CONSTRUCTION OF THE PROJECT ALWAYS CLEANING UP DIRT AND LOOSE MATERIAL AS CONSTRUCTION PROGRESSES.


5. CONTRACTOR TO INSPECT AND MAINTAIN THE AREAS LISTED BELOW AT LEAST ONCE EVERY FOURTEEN (14) CALENDAR DAYS AND WITHIN 24 HOURS OF THE END OF A STORM EVENT OF 0.5 INCHES OR GREATER.


- ••• DISTURBED AREAS OF THE CONSTRUCTION SITE THAT HAVE NOT BEEN FINALLY STABILIZED. ••• AREAS USED FOR STORAGE OF MATERIALS THAT ARE EXPOSED TO PRECIPITATION.
- ••• STRUCTURAL CONTROL MEASURES.
- ••• LOCATIONS WHERE VEHICLES ENTER OR EXIT THE SITE.

6. CONTRACTOR TO BE RESPONSIBLE TO MAINTAIN EXISTING DITCHES AND/ OR CULVERTS UNOBSTRUCTED DRAINAGE AT ALL TIMES. WHERE SODDING IS


DISTURBED BY EXCAVATION ON BACKFILLING OPERATIONS, SUCH AREAS SHALL BE REPLACED BY SEEDING OR SODDING. SLOPES 4:1 OR STEPPER SHALL BE REPLACED BY CLOCK SODDING.

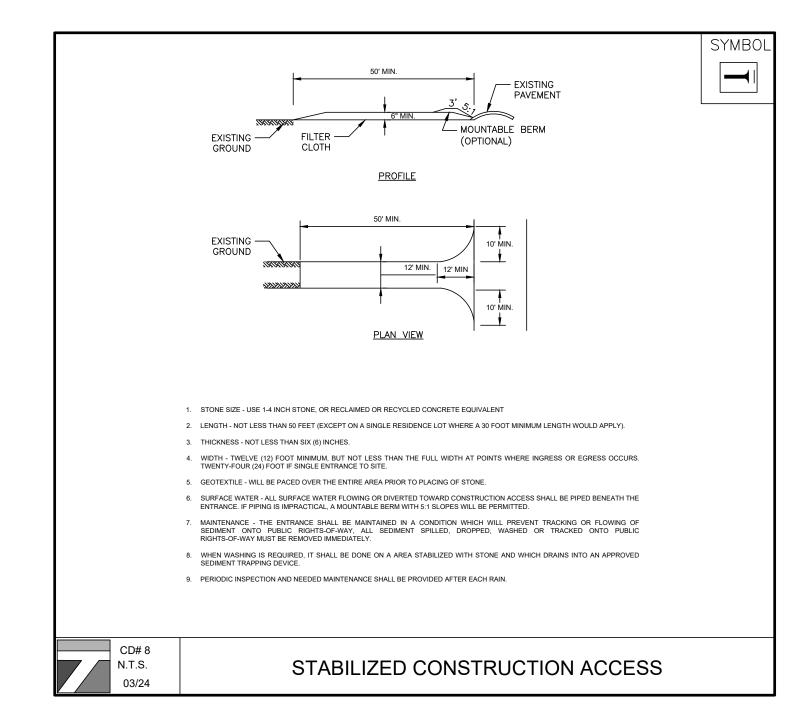


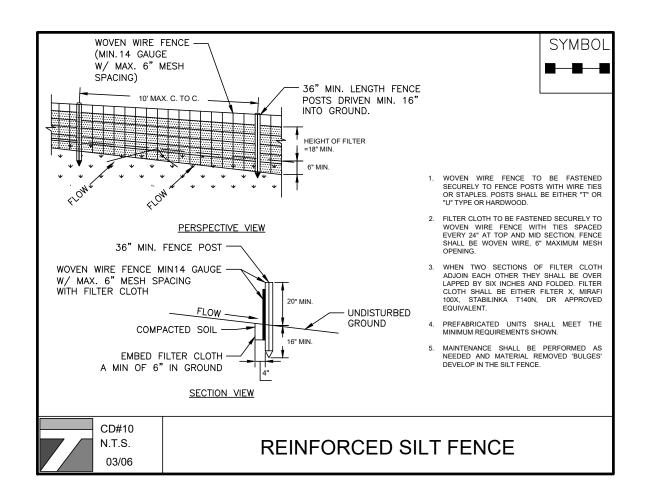


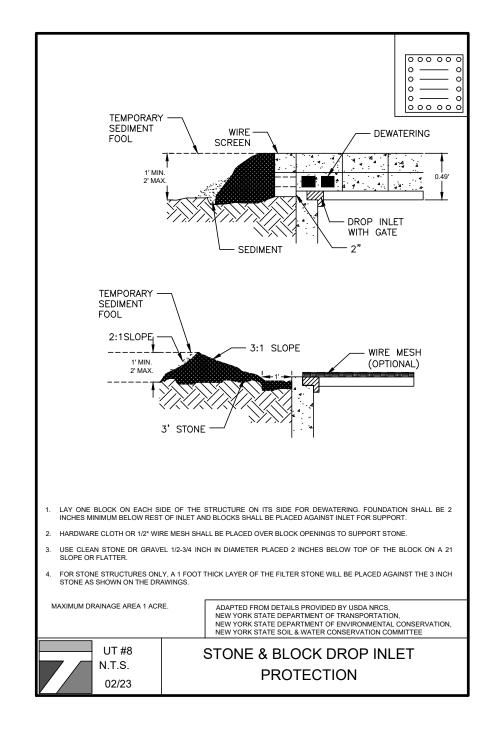



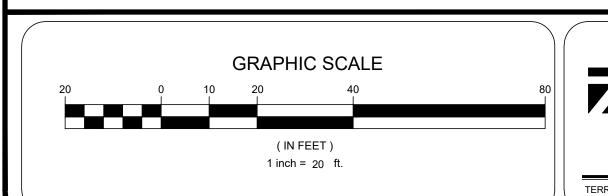

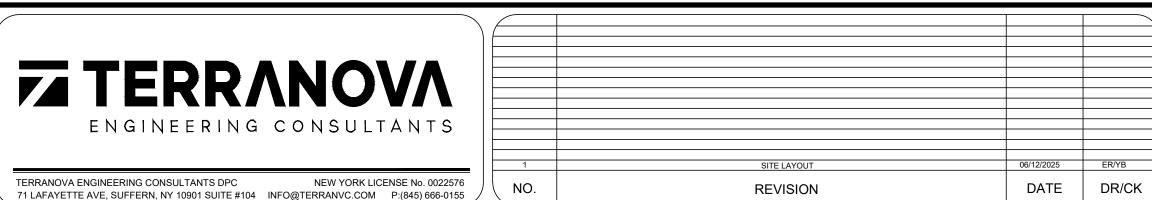

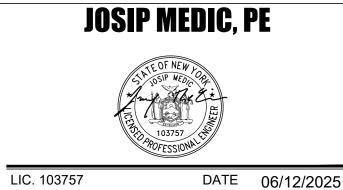


# **SOIL EROSION AND** SEDIMENT CONTROL PLAN

DESIGN BY:	DRAWN BY:	CHECKED BY:
YB	EB	JM

# 40 MERRIEWOLD LN S

40 MERRIEWOLD LANE S, VILLAGE OF SOUTH BLOOMING GROVE, TOWN OF BLOOMING GROVE, ORANGE COUNTY, NY 10950 SBL 210-1-4

DRAWING NUMBER:	SCALE:	FILE NO.:	DATE:
<b>06</b> of <b>07</b>	1"=20'	25130	05/13/2025

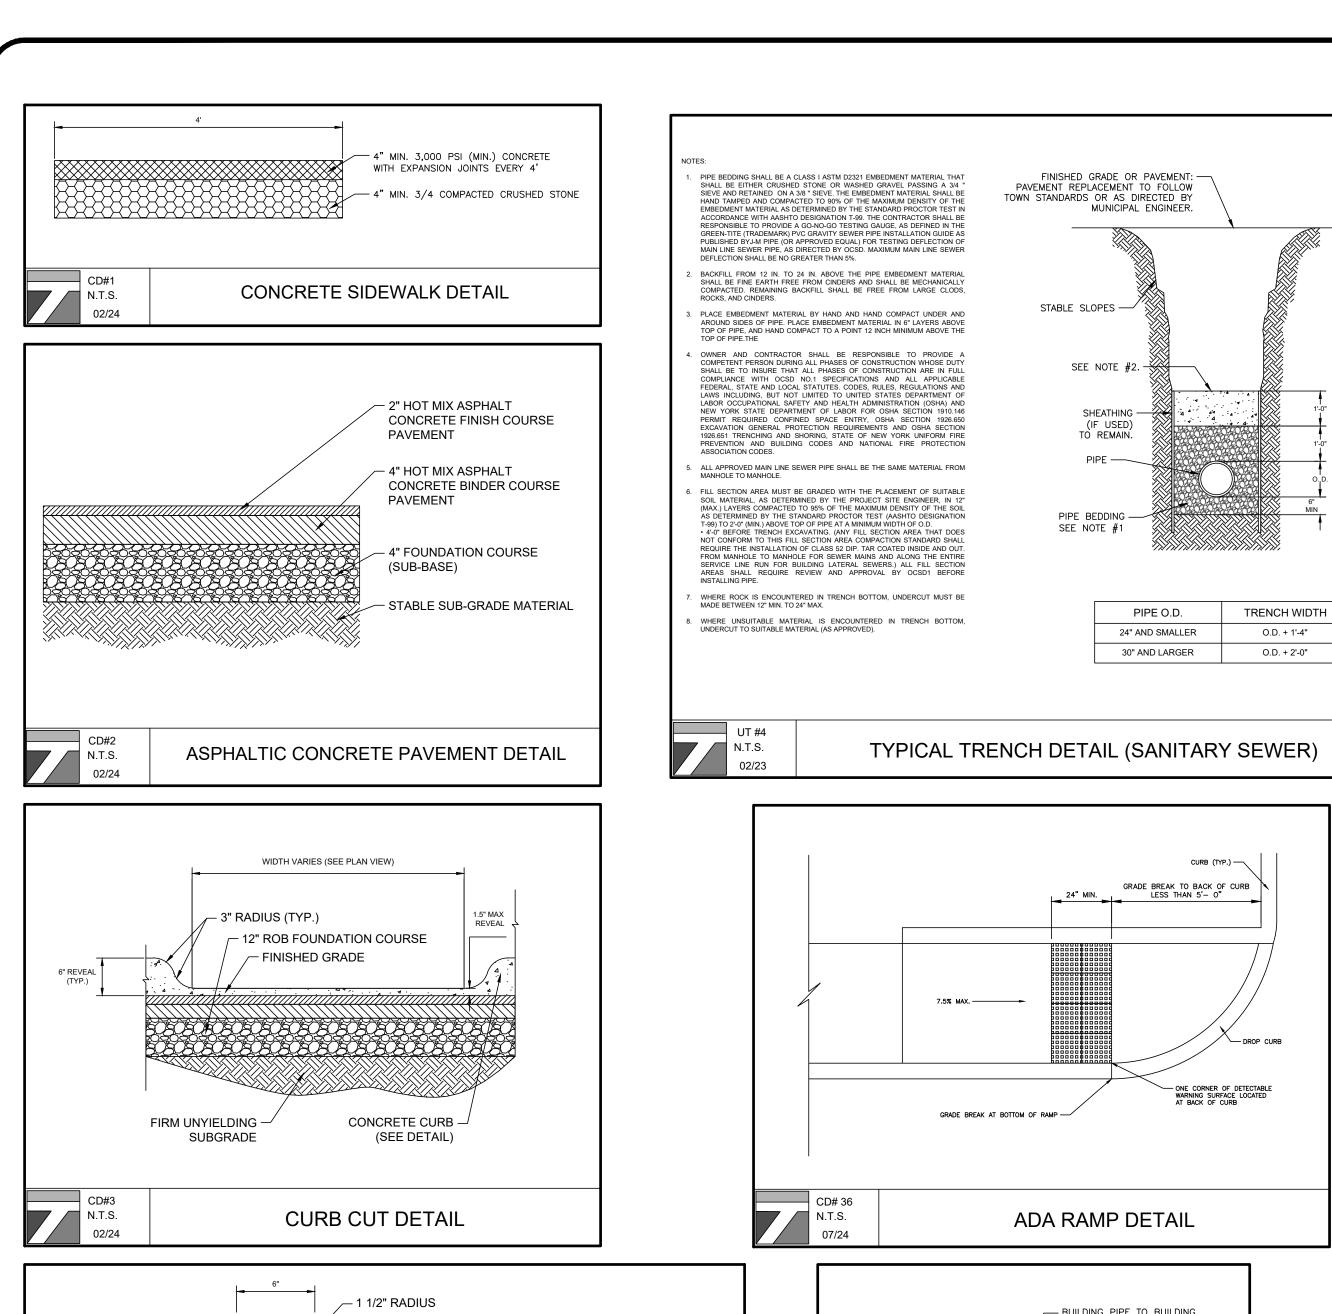

- SURFACING AS REQUIRED

- FOUNDATION COURSE

**GRANULAR MATERIAL** 

- 4" POROUS TILE WHEN REQUIRED

CONCRETE CURB DETAIL


1. CURB SHALL BE CAST IN PLACE. EXPANCION JOINTS OF 3/16"


WITH DUREX OR EQUAL.


N.T.S. 02/24 2. CONCRETE TO TEST 4000 PSI AT 28 DAYS


CELLULOSE OR SIMILAR MATERIAL SHALL BE PLACED AT THEN (10)


FOOT INTERVALS. CONCRETE TO BE 1:2:3 MIX DESIGN, AIR ENTRAINED

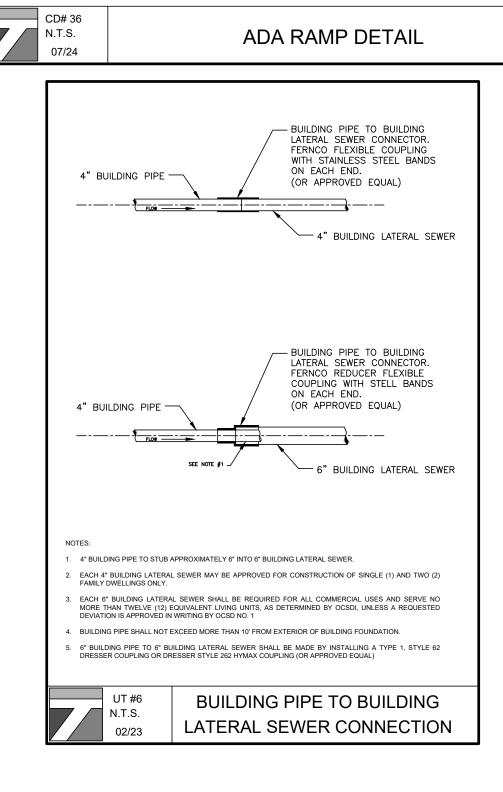

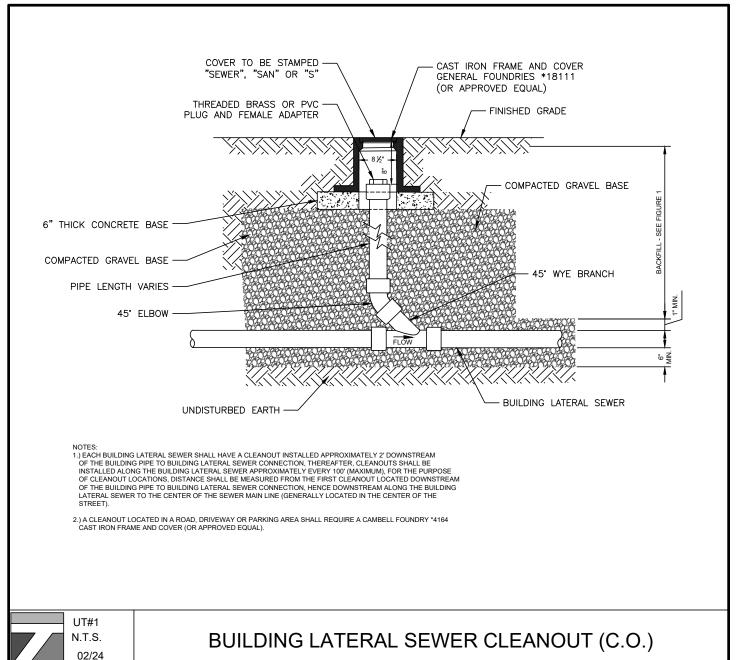


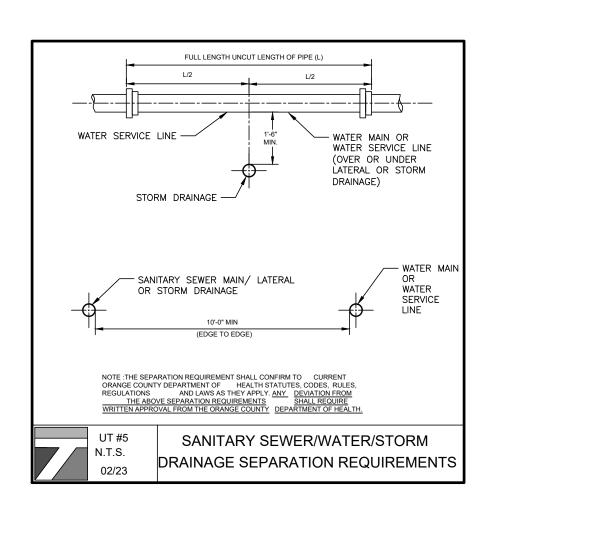


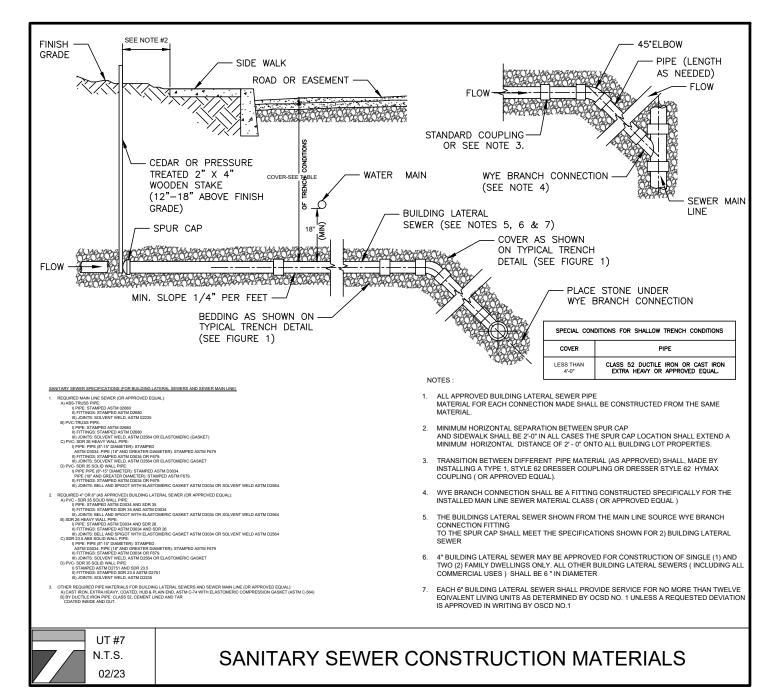

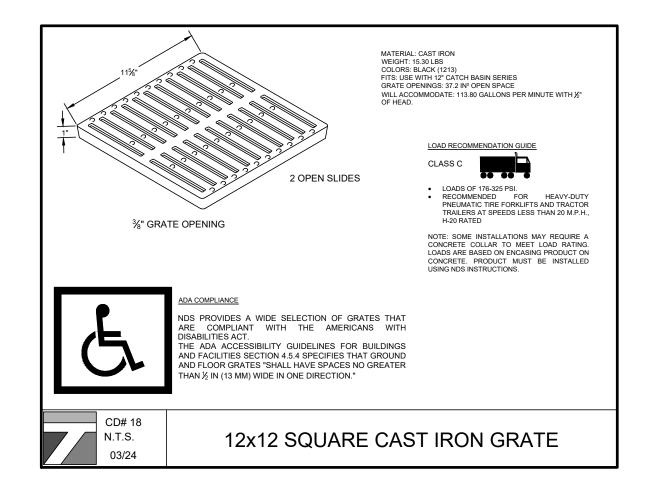



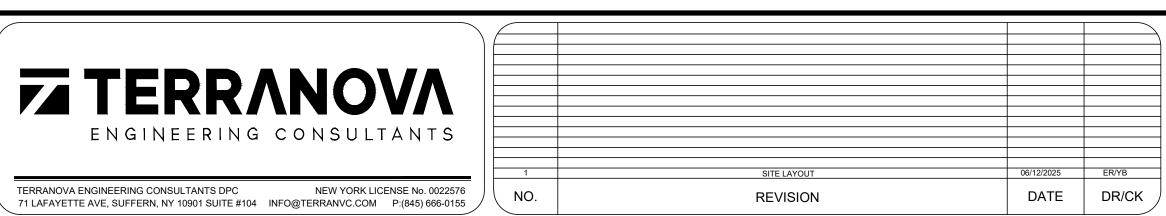

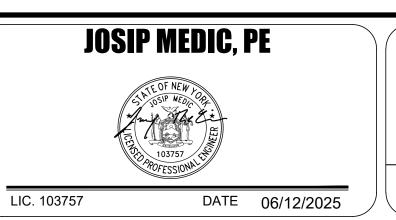

D	ETAIL SHEET		
DESIGN BY:	DRAWN BY:	CHECKED BY:	
VD		18.4	

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7 of <b>07</b>	NTS	25130	05/13/2025